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UWU/AHEAD/SLE/ST/04 FOUNDATION CROSS SECTION
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UWU/AHEAD/SLE/ELE/10

UWU/AHFAD/SLF/ELE/02 GROUND FLOOR POWER POINT ARRANGEMENT
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FIRST FLOOR SURFACE CONDUIT LAYOUT FOR POWER CABLE
UWU/AHFAD/SLF/ELE/05
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UWU/AHFAD/SLE/ELE/09
UWU/AHFAD/SLE/ELE/09
UWU/AHFAD/SLE/ELE/09

UWU/AHEAD/SLE/ELE/10

CLIENT:


VICE CHANCELLOR UVA WELLASSA UNIVERSITY PASSARA ROAD, BADULLA, SRI LANKA

CONSULTANT:


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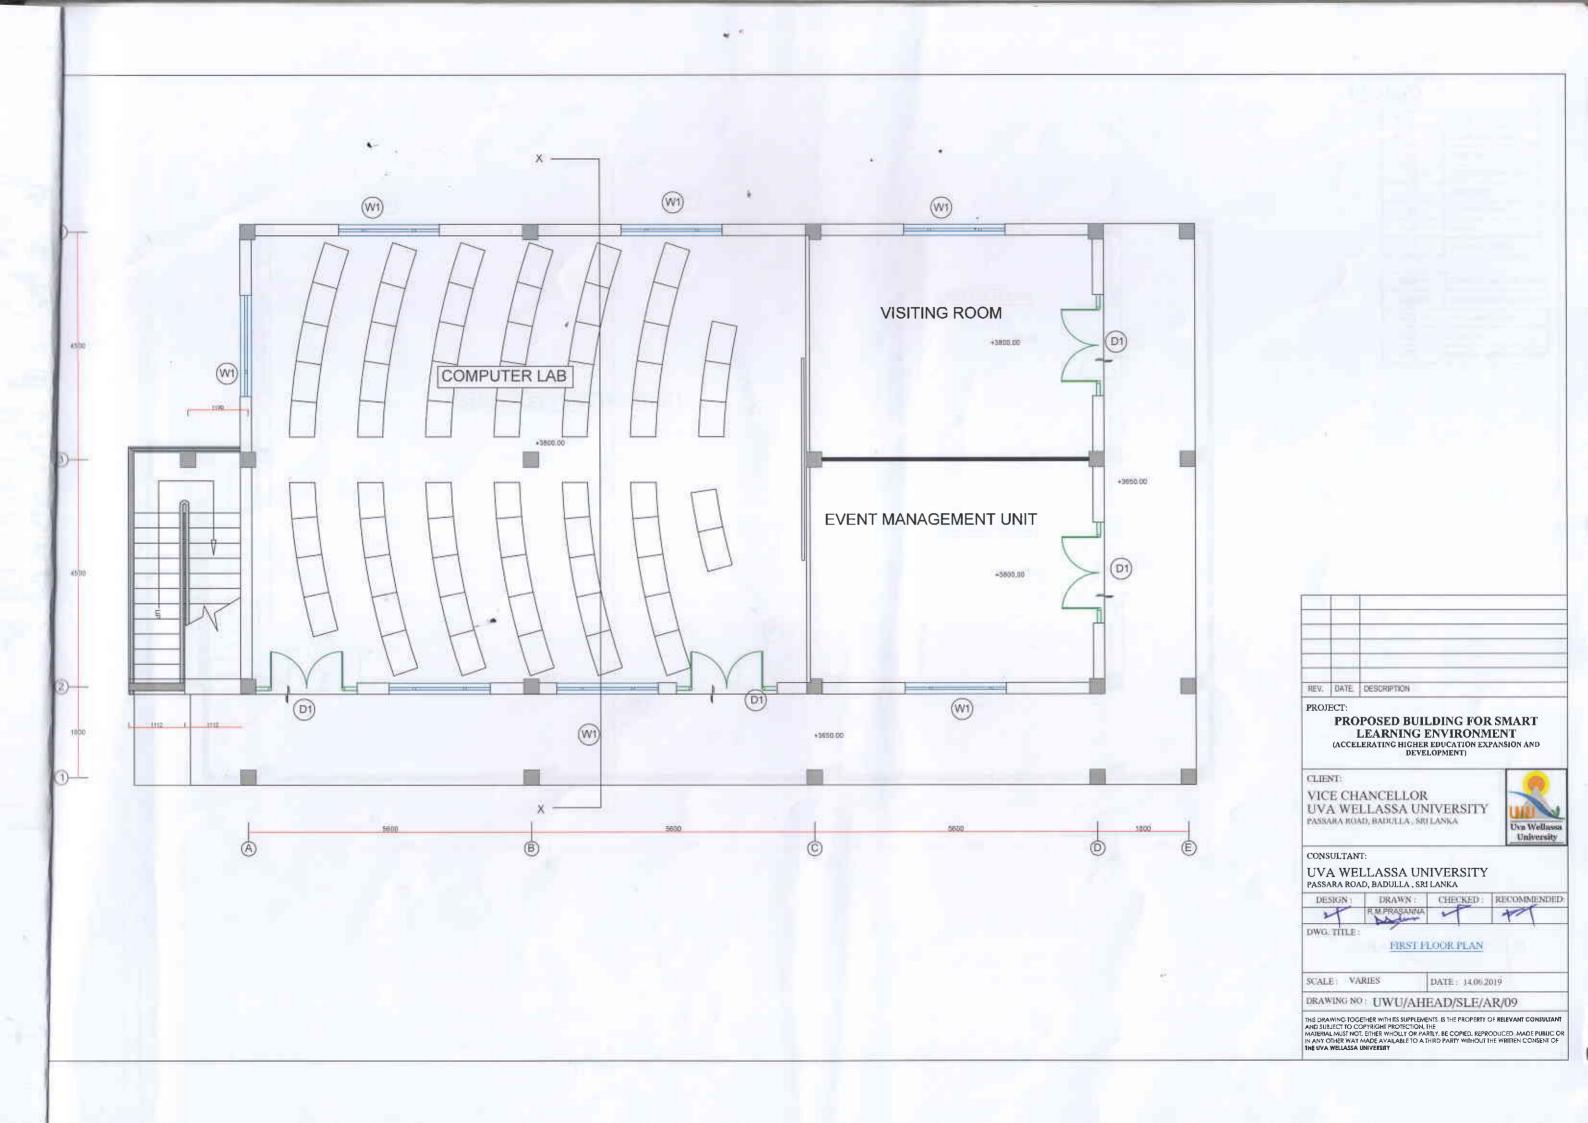
MAINTENANCE DIVISION
UVA WELLASSA UNIVERSITY
PASSARA ROAD, BADULLA, SRI LANKA







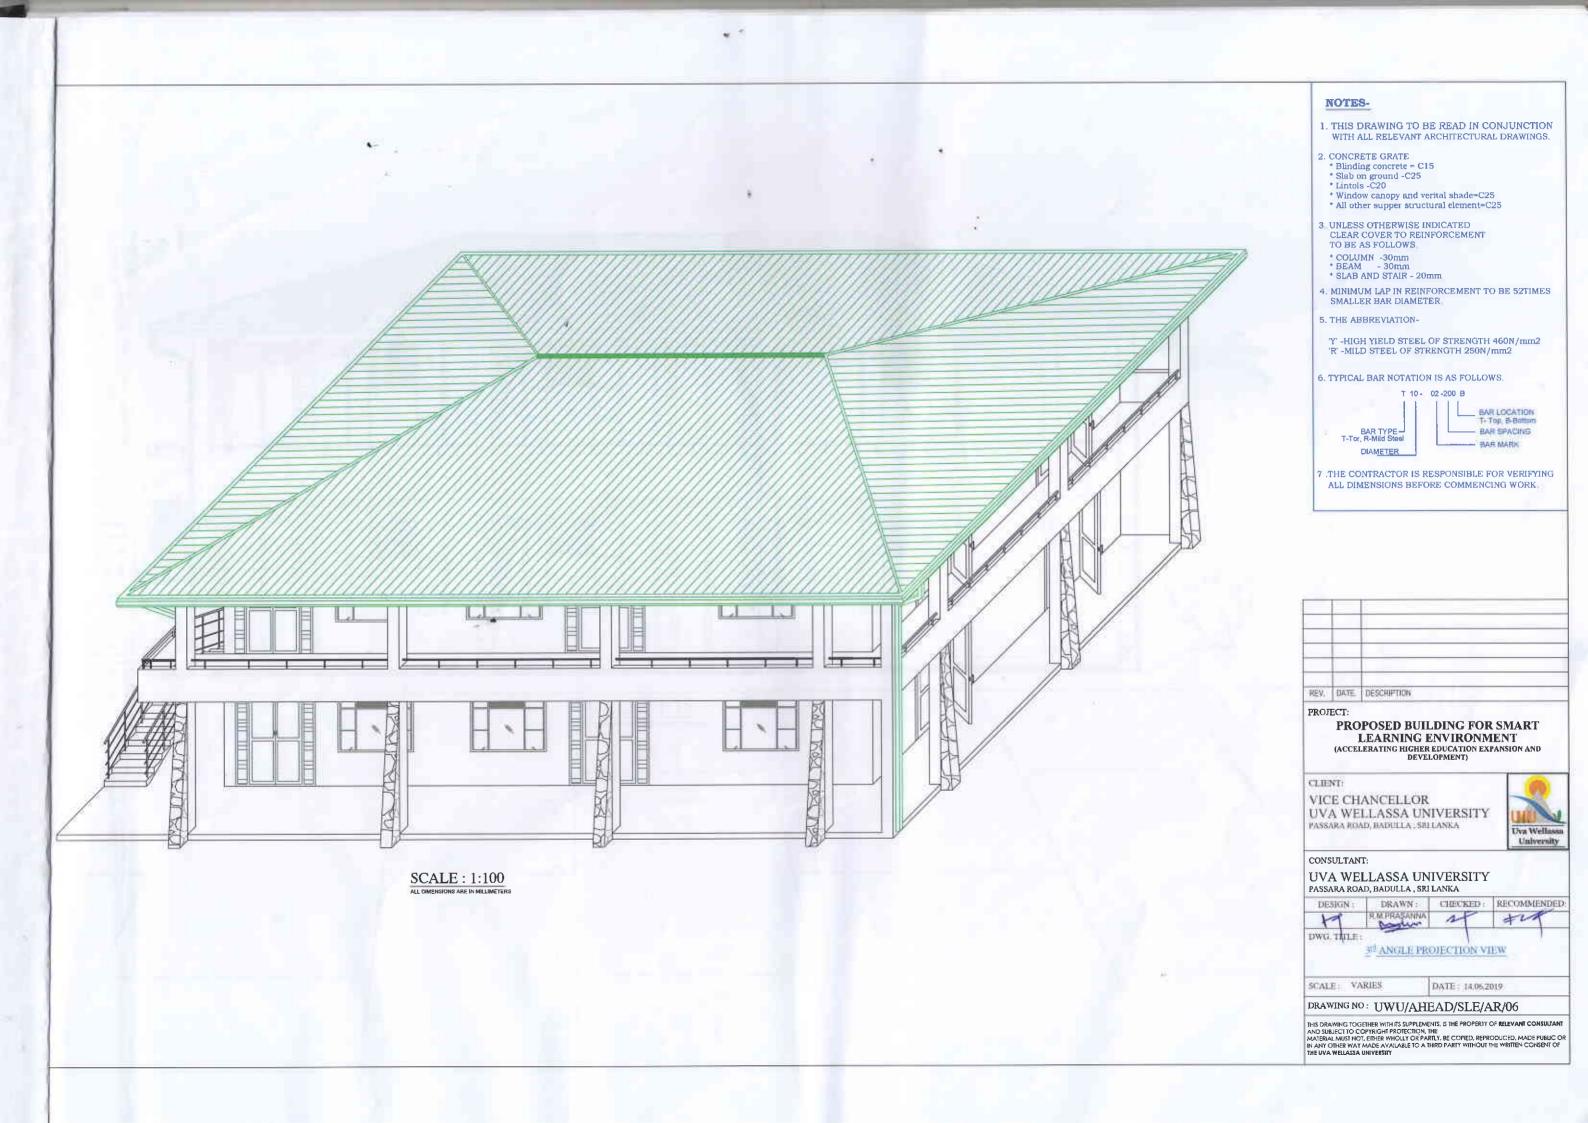





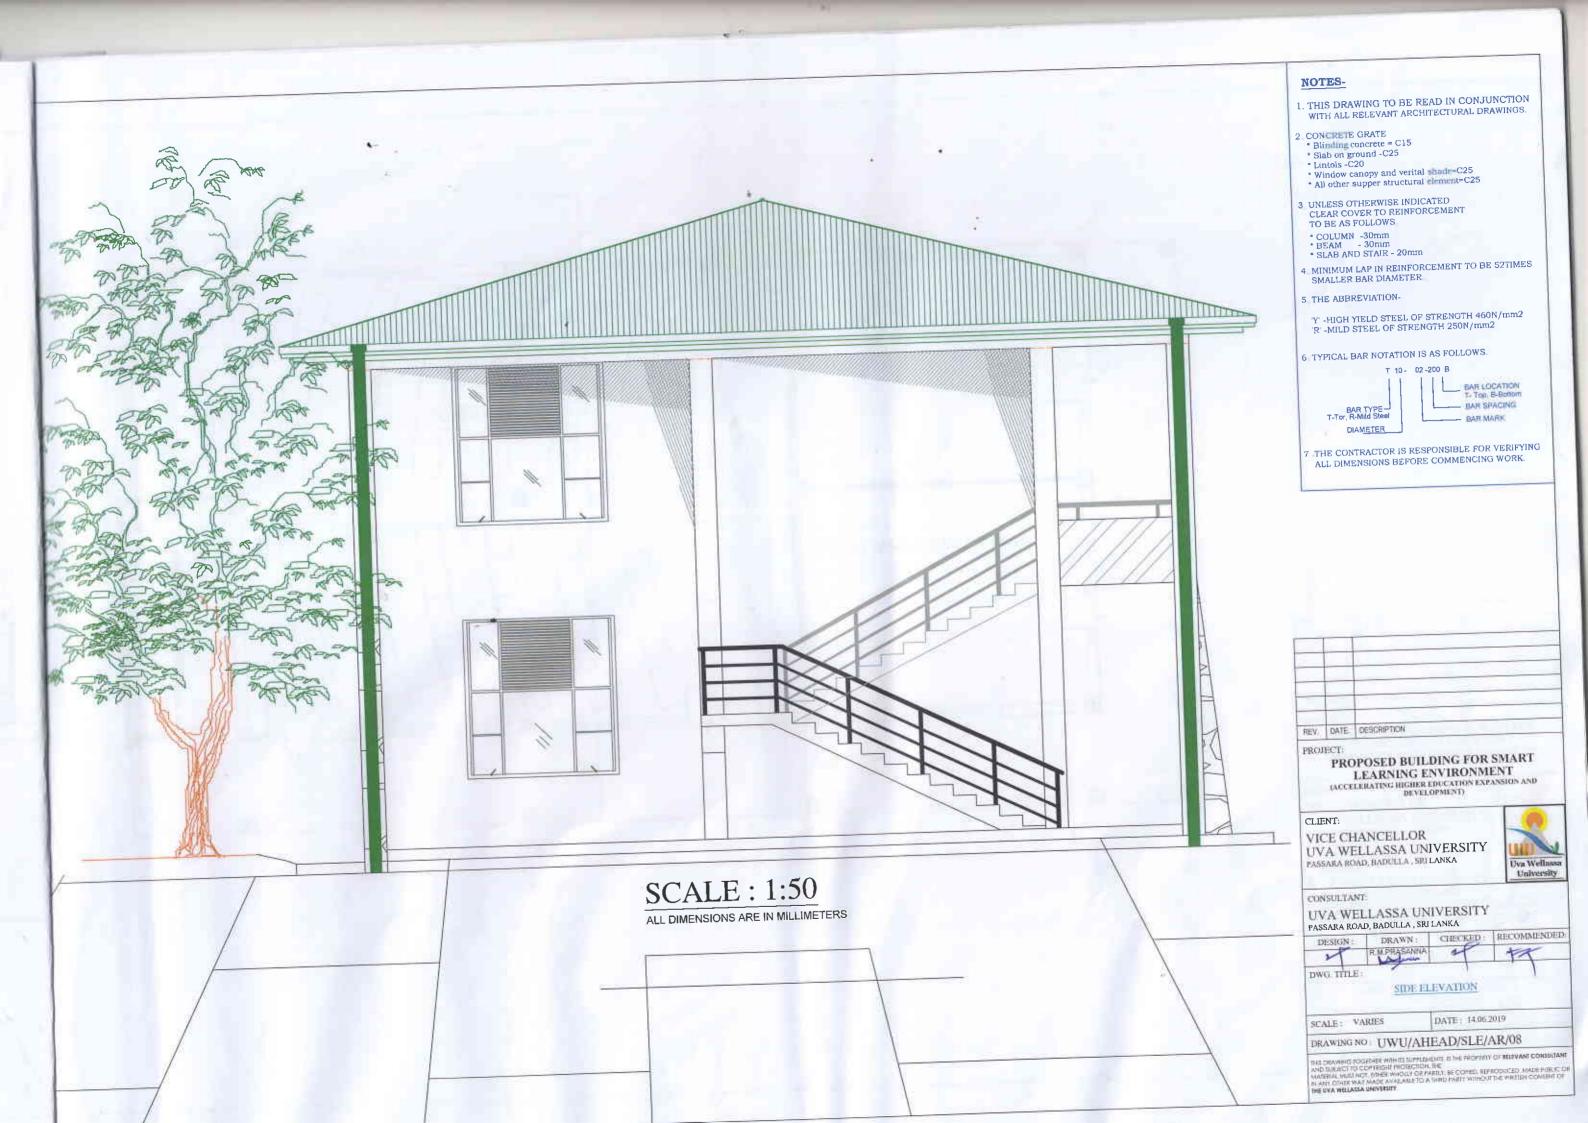


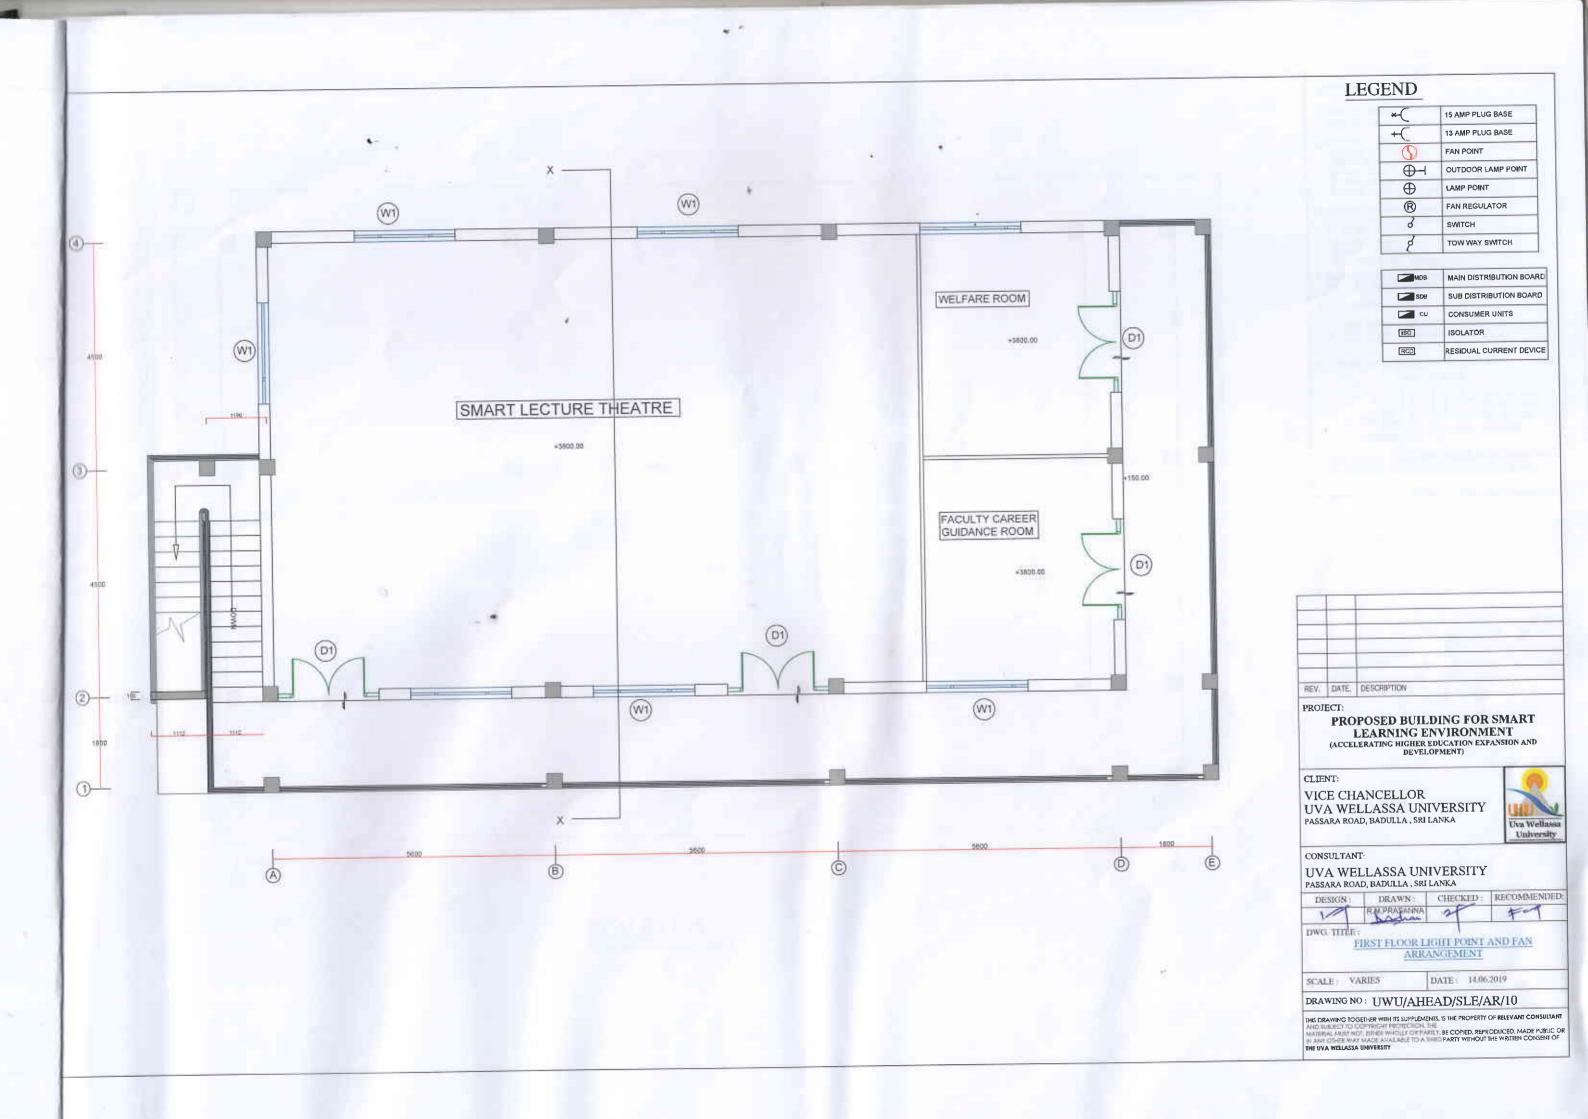

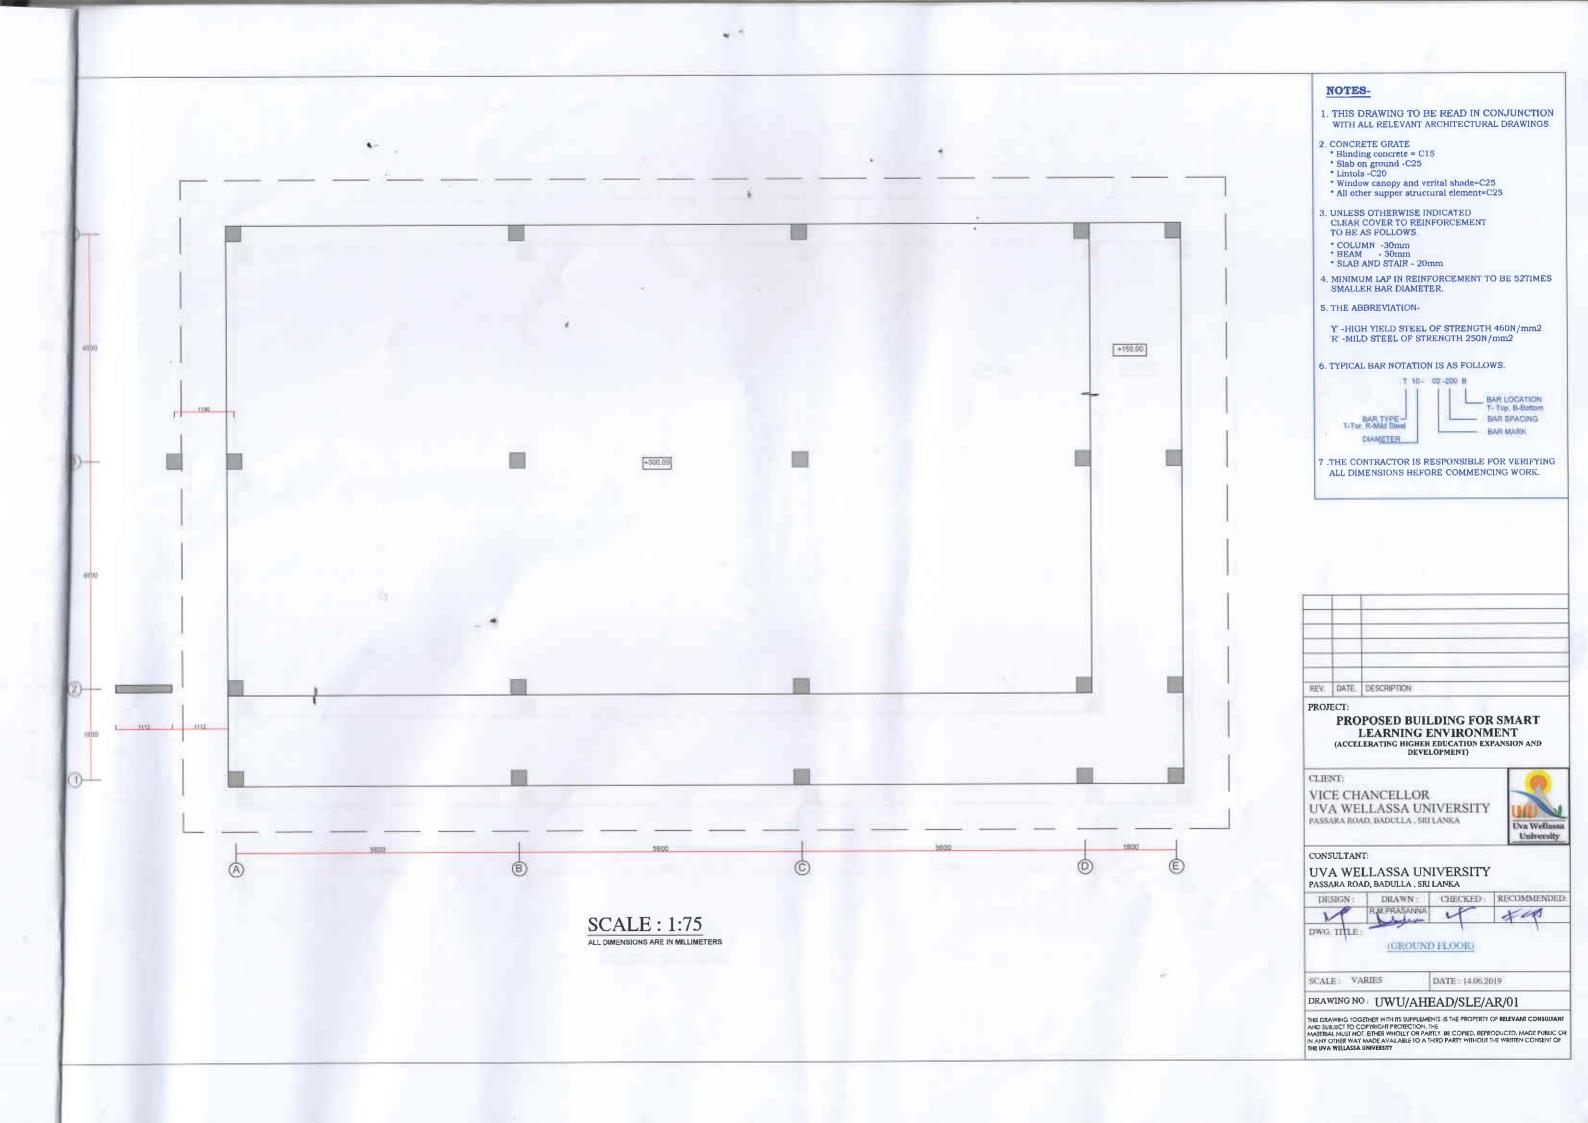

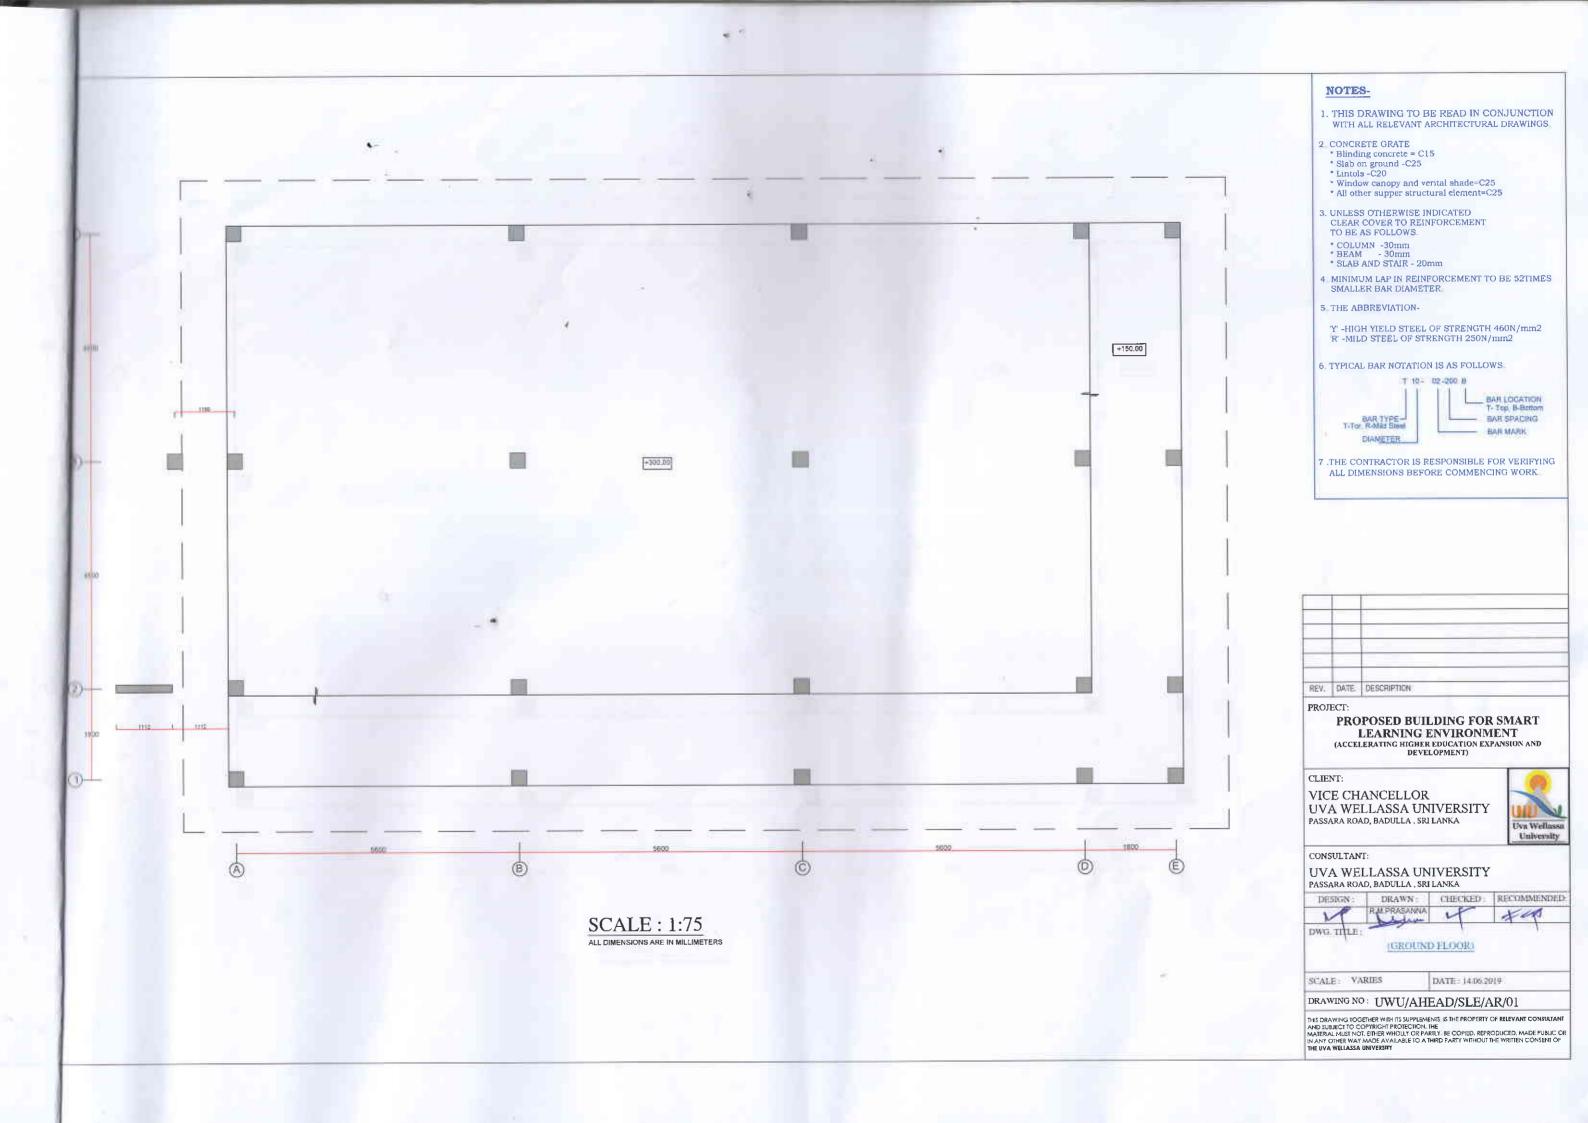

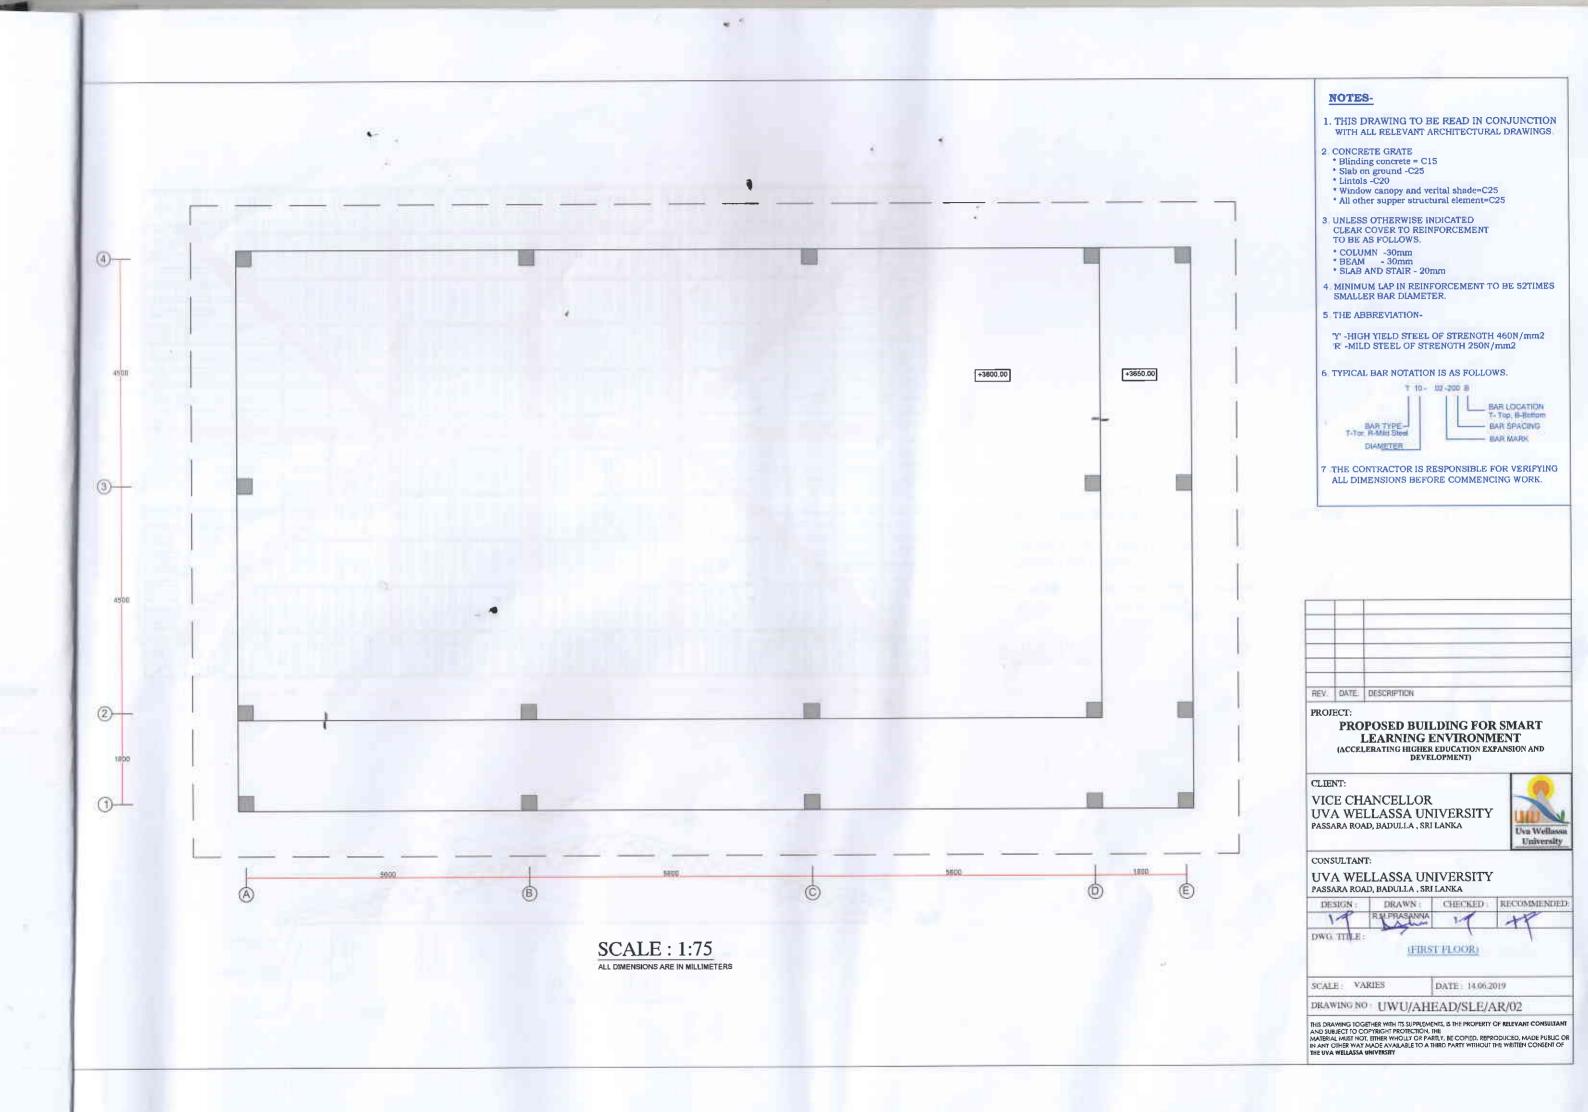

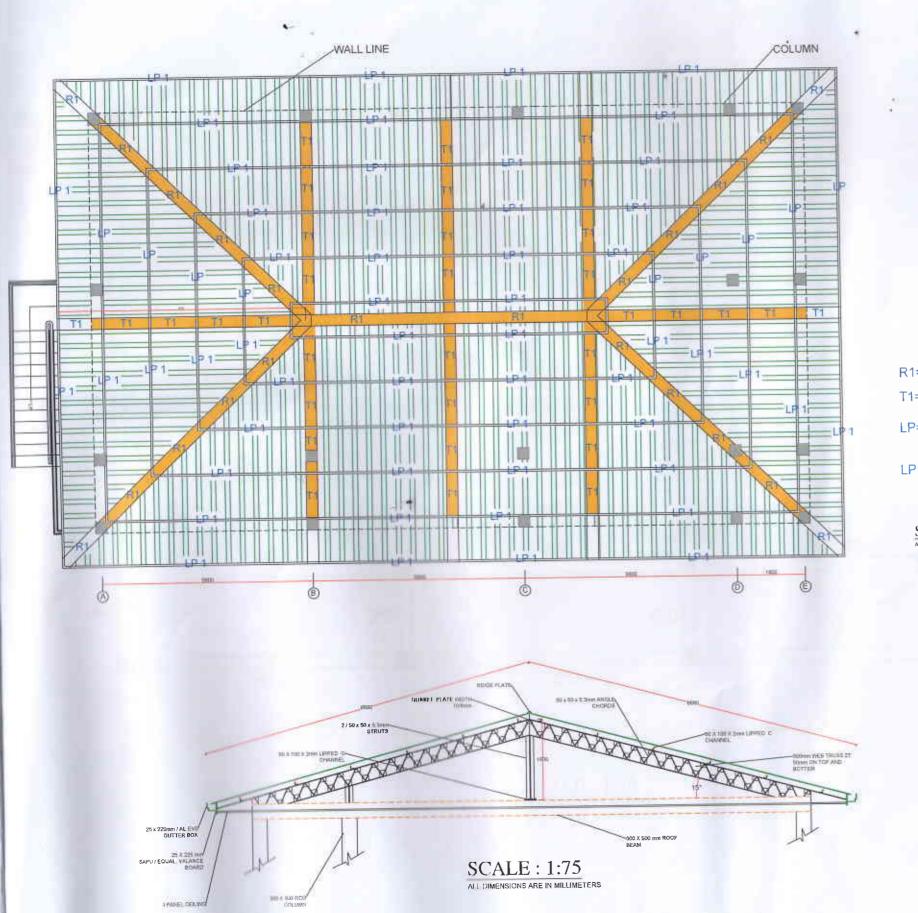


NOTES-

- 1 THIS DRAWING TO BE READ IN CONJUNCTION WITH ALL RELEVANT ARCHITECTURAL DRAWINGS
- 2 CONCRETE GRATE
- Blinding concrete = C15

- * Slab on ground -C25
 * Lintois -C20
 * Window canopy and verital shade=C25
 * All other supper structural element=C25
- 3 UNLESS OTHERWISE INDICATED CLEAR COVER TO REINFORCEMENT TO BE AS FOLLOWS.
- * COLUMN -30mm
- * BEAM 30mm * SLAB AND STAIR 20mm
- 4 MINIMUM LAP IN REINFORCEMENT TO BE 52TIMES SMALLER BAR DIAMETER
- 5. THE ABBREVIATION-
- Y -HIGH YIELD STEEL OF STRENGTH 460N/mm2 'R' -MILD STEEL OF STRENGTH 250N/mm2



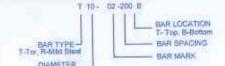

THE CONTRACTOR IS RESPONSIBLE FOR VERIFYING ALL DIMENSIONS BEFORE COMMENCING WORK


R1= TRUSS 2T 50mm ON TOP

T1= 300mm WEB TRUSS 2T 50mm ON TOP AND BOTTOM

LP= 150X50X 2.3mm Thk. LIPPED CHANNEL 1200mm INTERVALS

LP1= 100X50X 2.3mm Thk. LIPPED CHANNEL Approx 1200mm INTERVALS

SCALE: 1:100

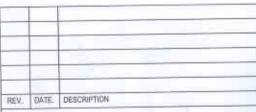

PROPOSED BUILDING FOR SMART LEARNING ENVIRONMENT (ACCELERATING HIGHER EDUCATION EXPANSION AND

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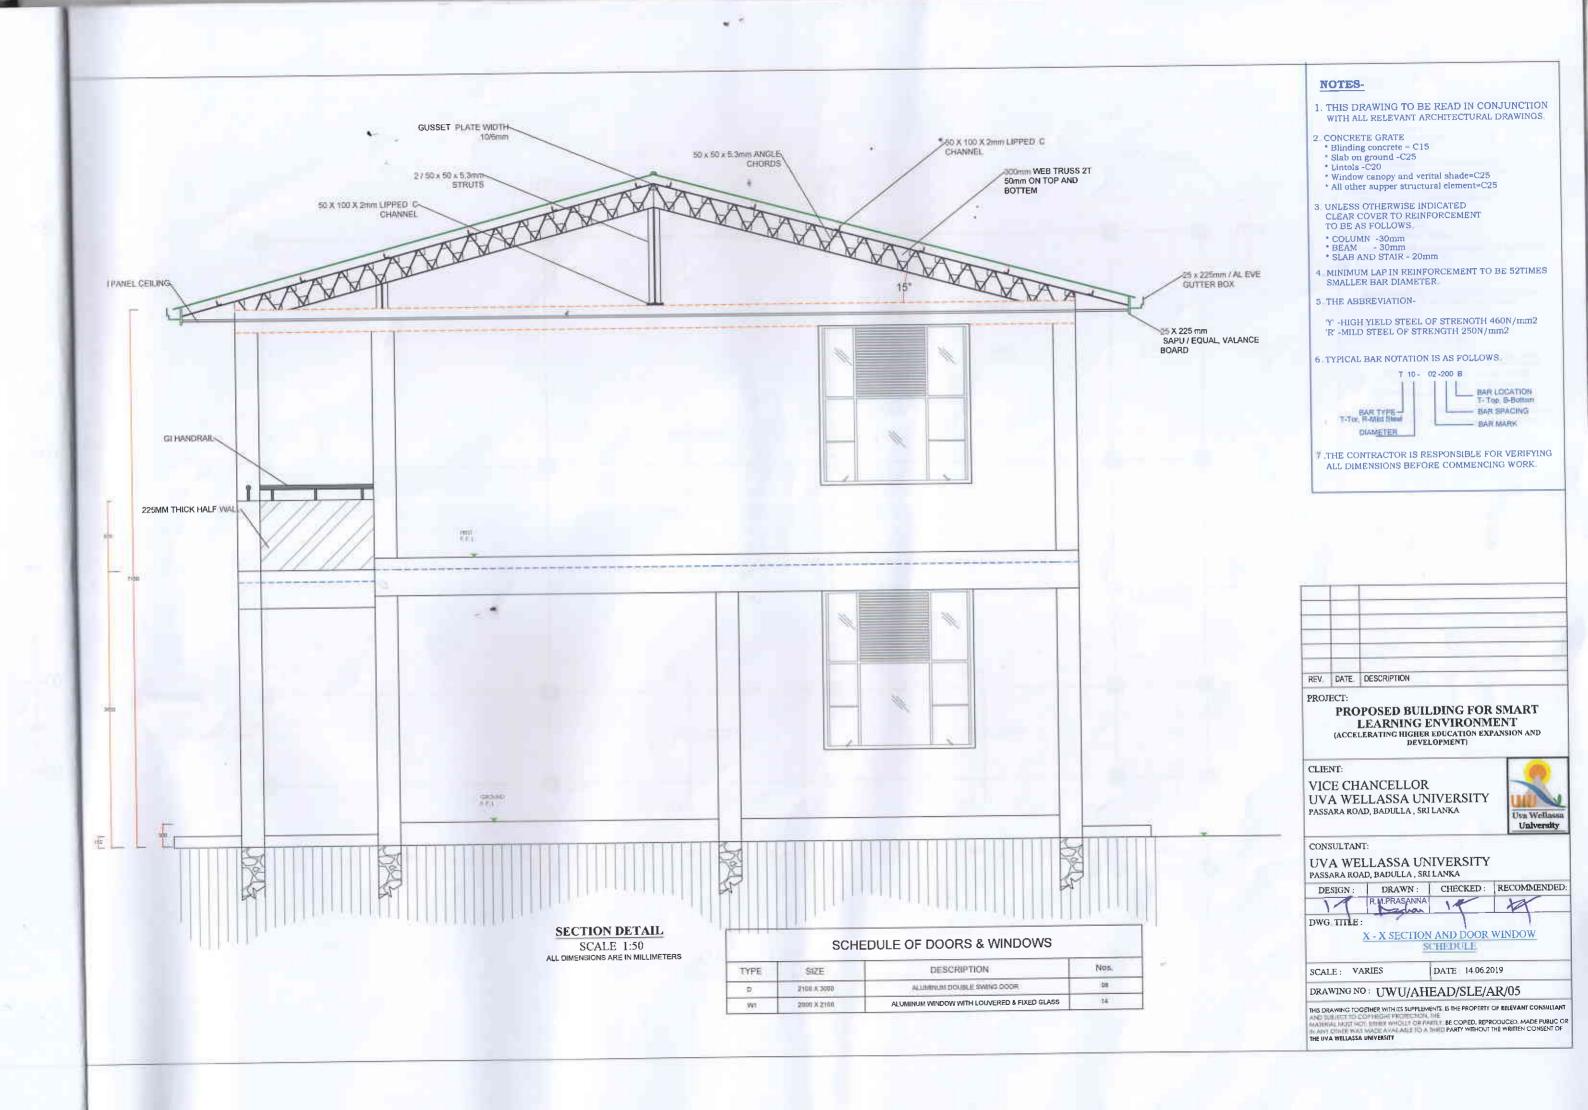
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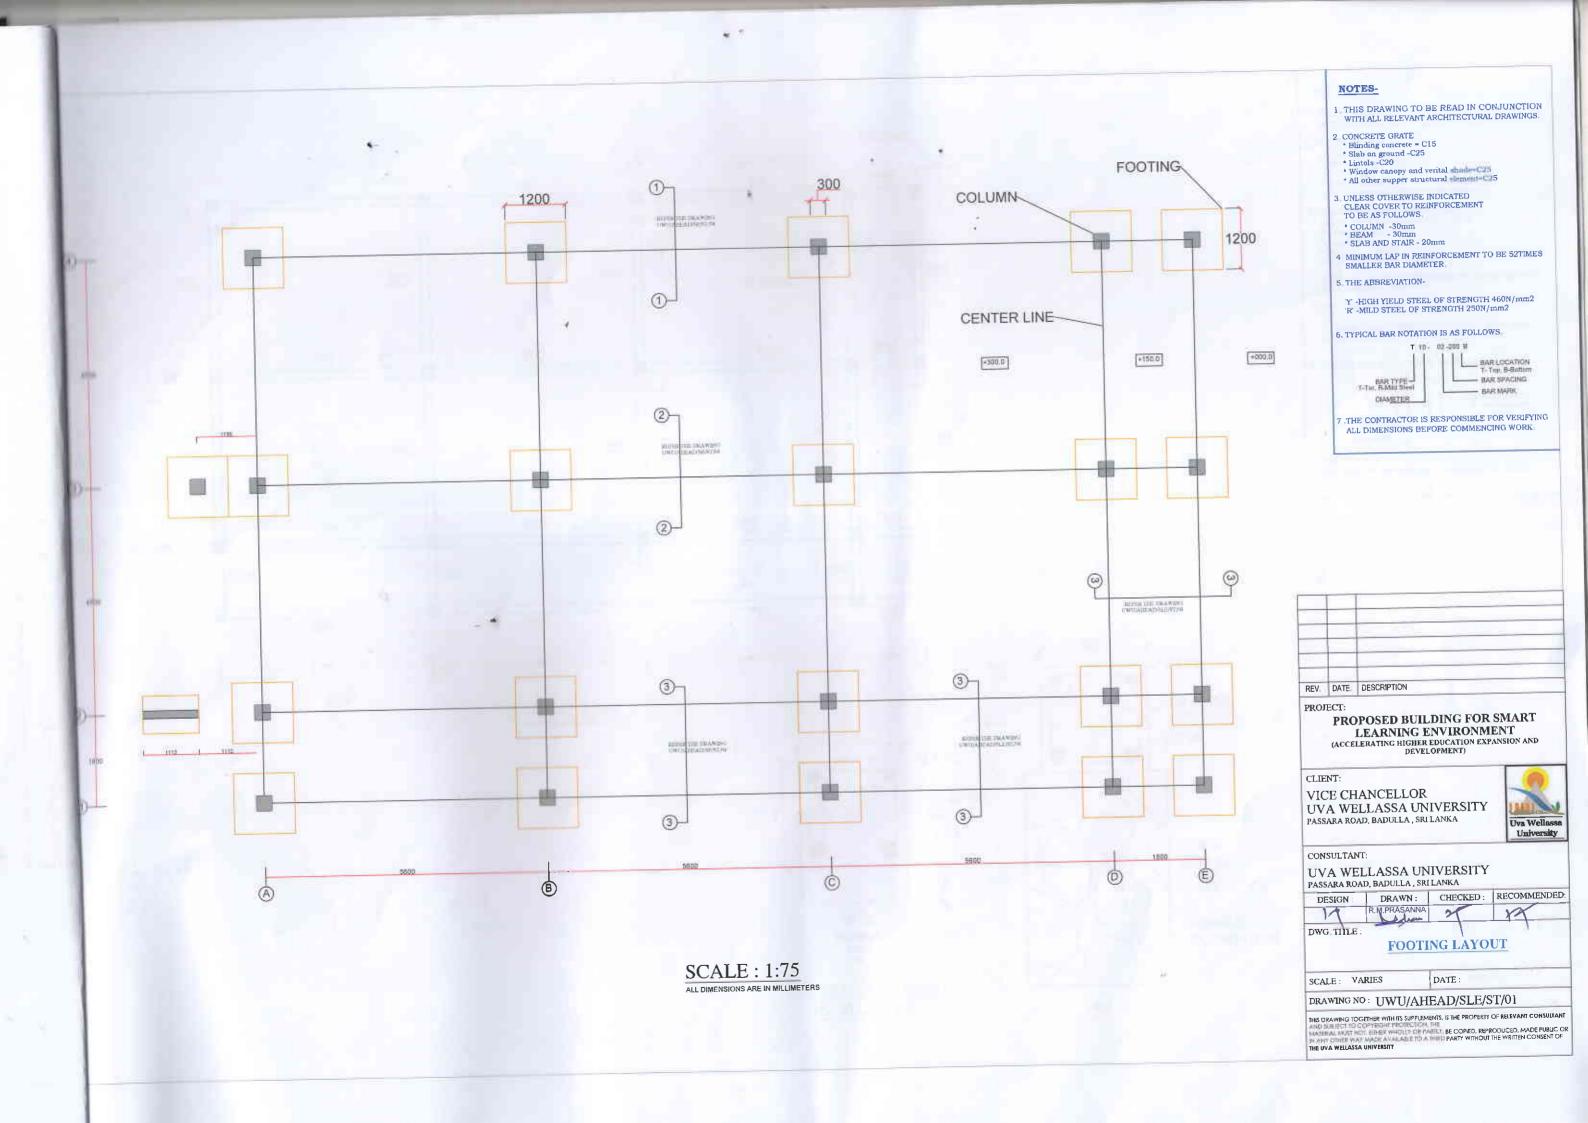
DWG. TITLE (ROOF PLAN AND SECTION DETAIL)


SCALE: VARIES DATE: 14.96.2019


DRAWING NO: UWU/AHEAD/SLE/AR/03


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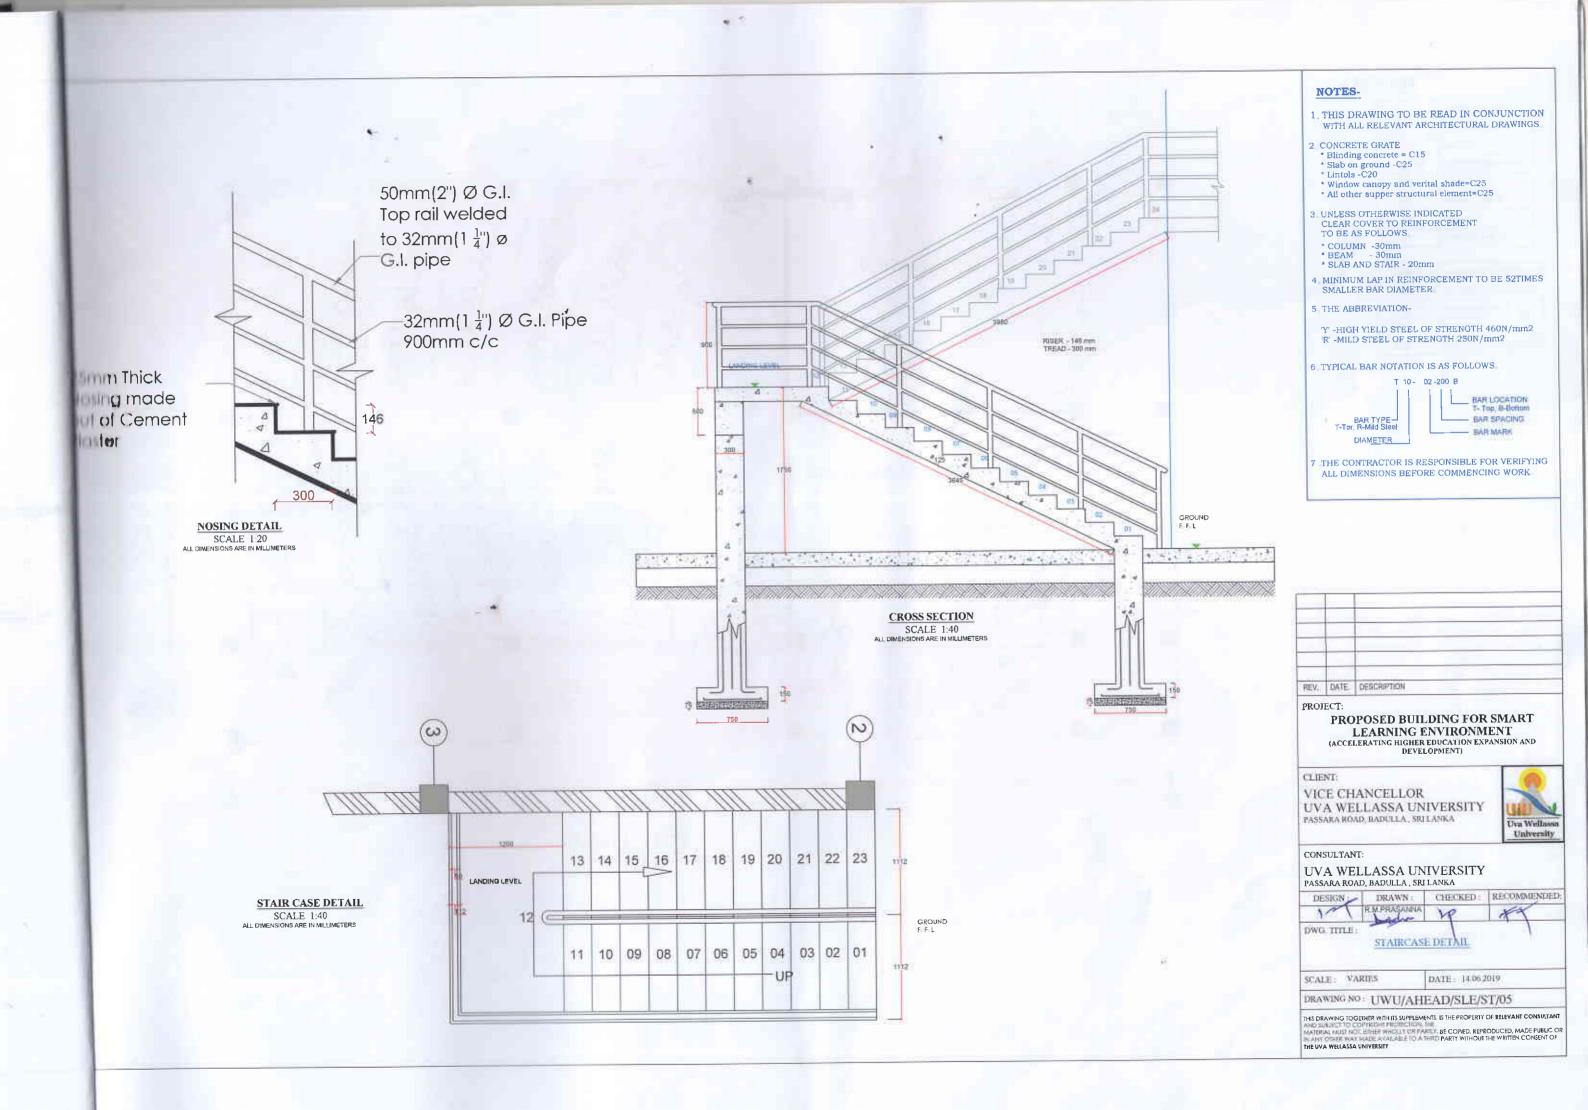







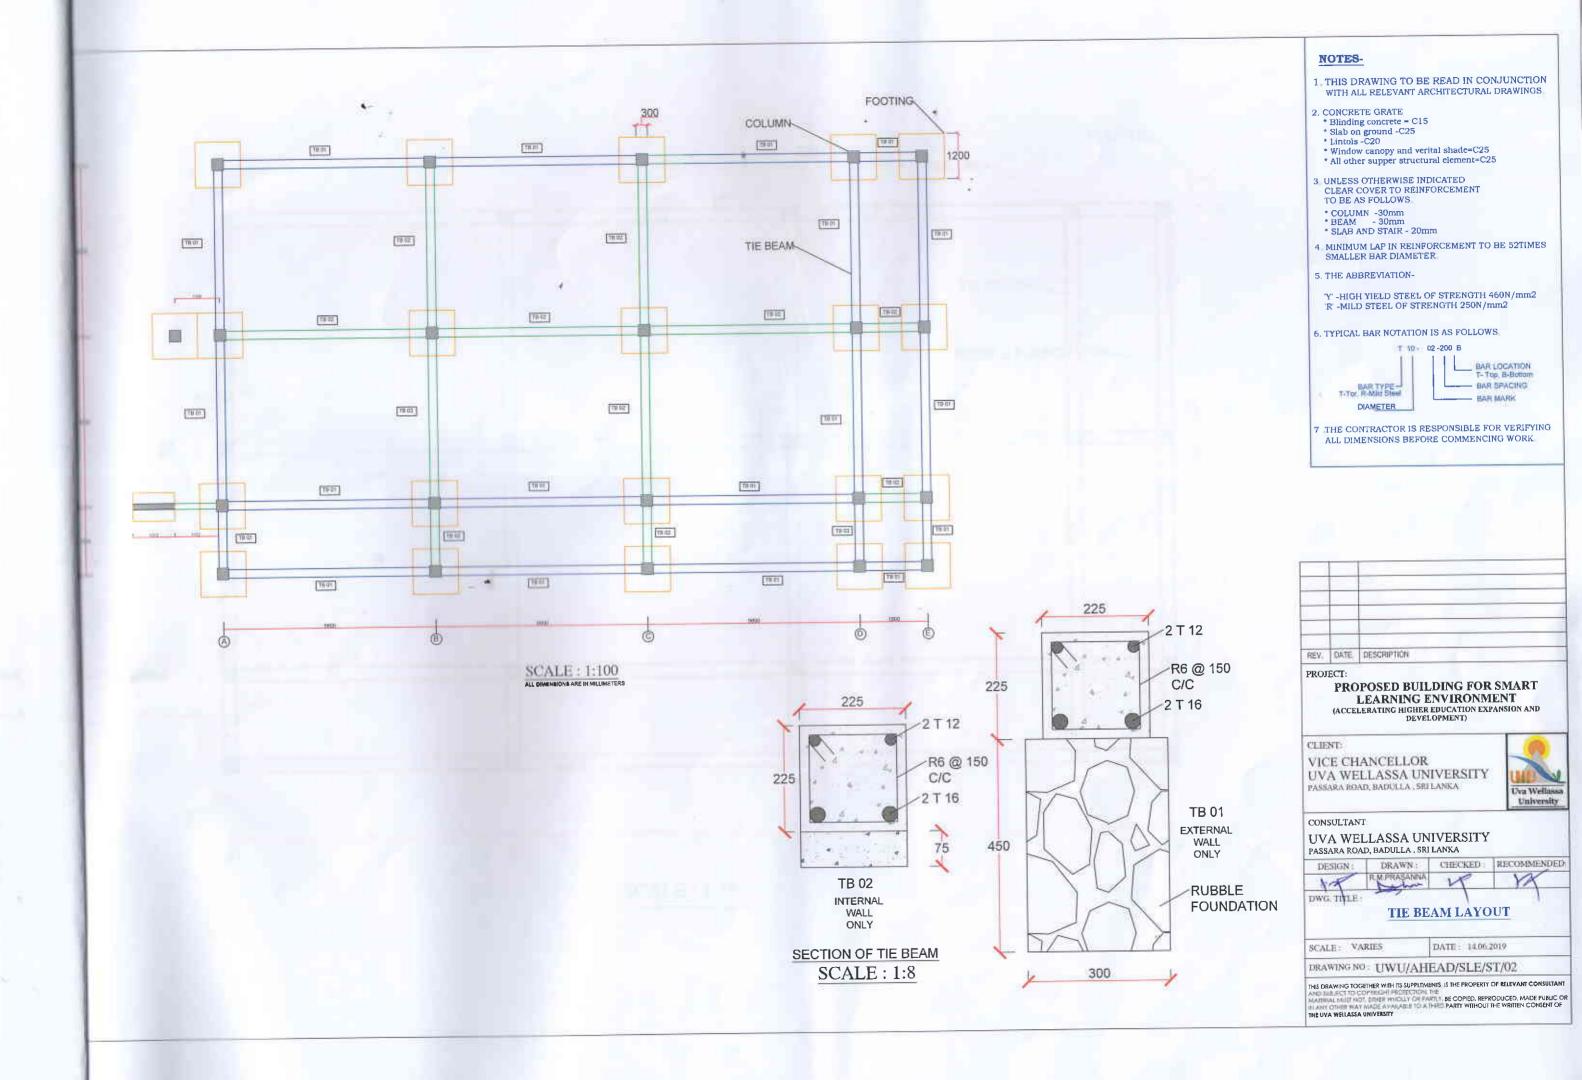

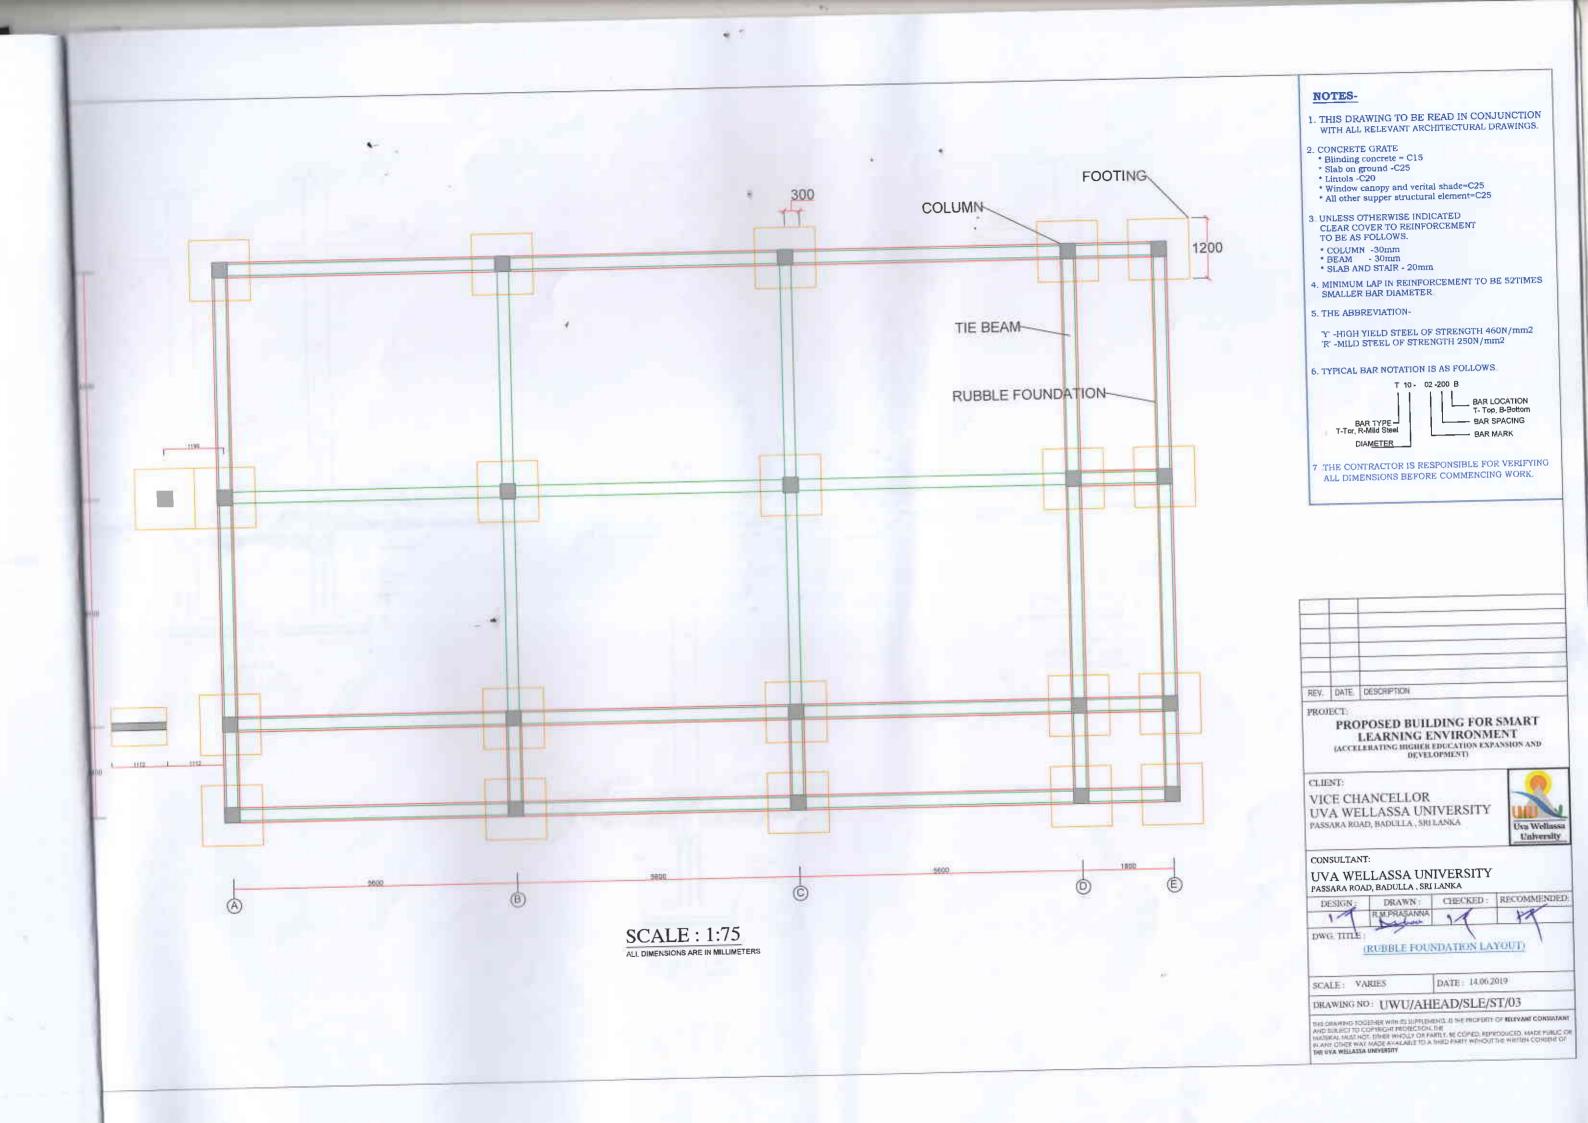


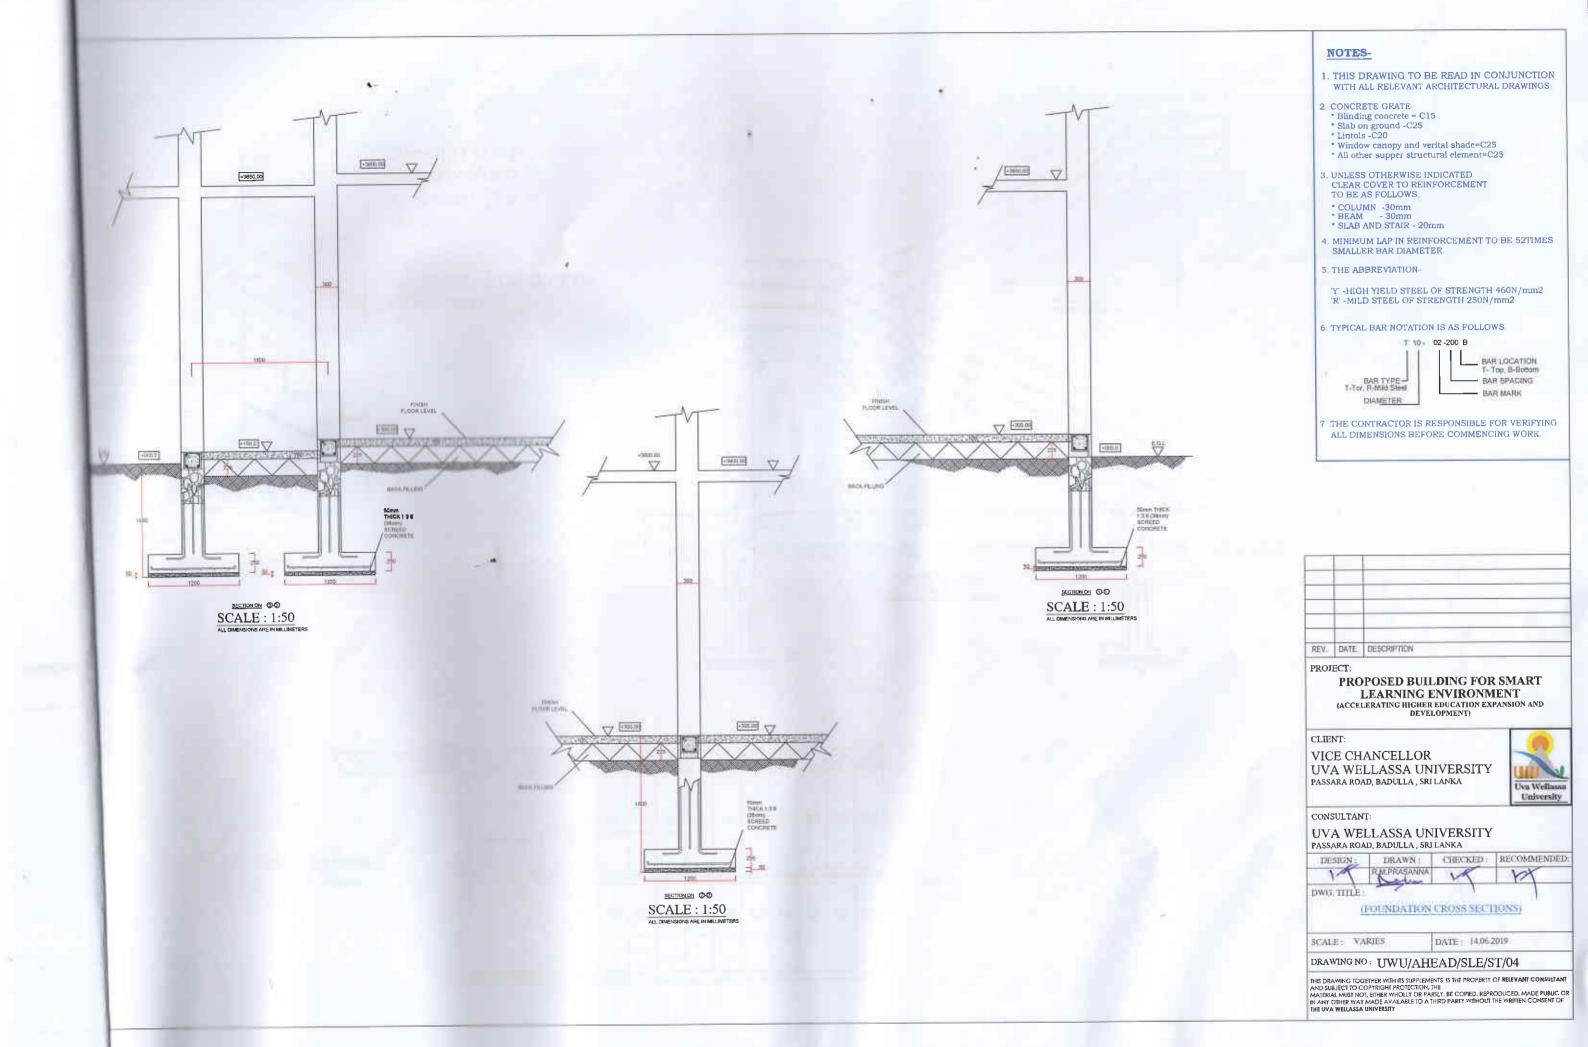

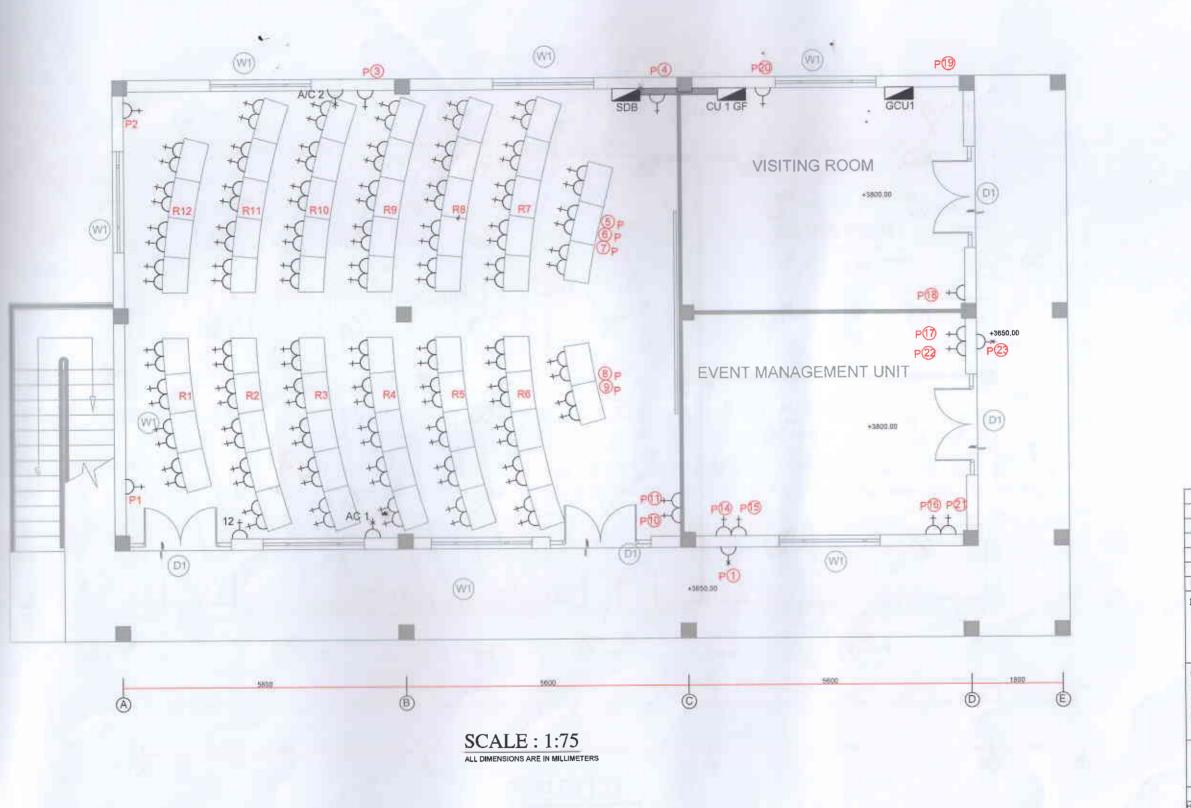

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®	FAN REGULATOR
8	SWITCH
ß	TOW WAY SWITCH

МОВ	MAIN DISTRIBUTION BOARD	
SDB	SUB DISTRIBUTION BOARD	
CU	CONSUMER UNITS	
ISO	ISOLATOR	
RED	RESIDUAL CURRENT DEVICE	

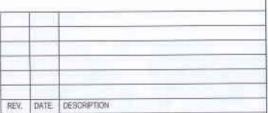

PROJEC

PROPOSED BUILDING FOR SMART LEARNING ENVIRONMENT (ACCELERATING HIGHER EDUCATION EXPANSION AND DEVELOPMENT)

CLIENT

VICE CHANCELLOR
UVA WELLASSA UNIVERSITY
PASSARA ROAD, BADULLA SRILANKA



CONSULTANT:

UVA WELLASSA UNIVERSITY PASSARA ROAD, BADULLA , SRI LANKA

DESIGN: DRAWN: CHECKED: RECOMMENDED

H.C. WIESINGHE RAMPRASANNA

DWO TITLE:

GROUND FLOOR POWER POINT


ARRANGEMENT

SCALE: VARIES

DATE: 14.06.2019


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ISOLATOR
RESIDUAL CURRENT DEVICE

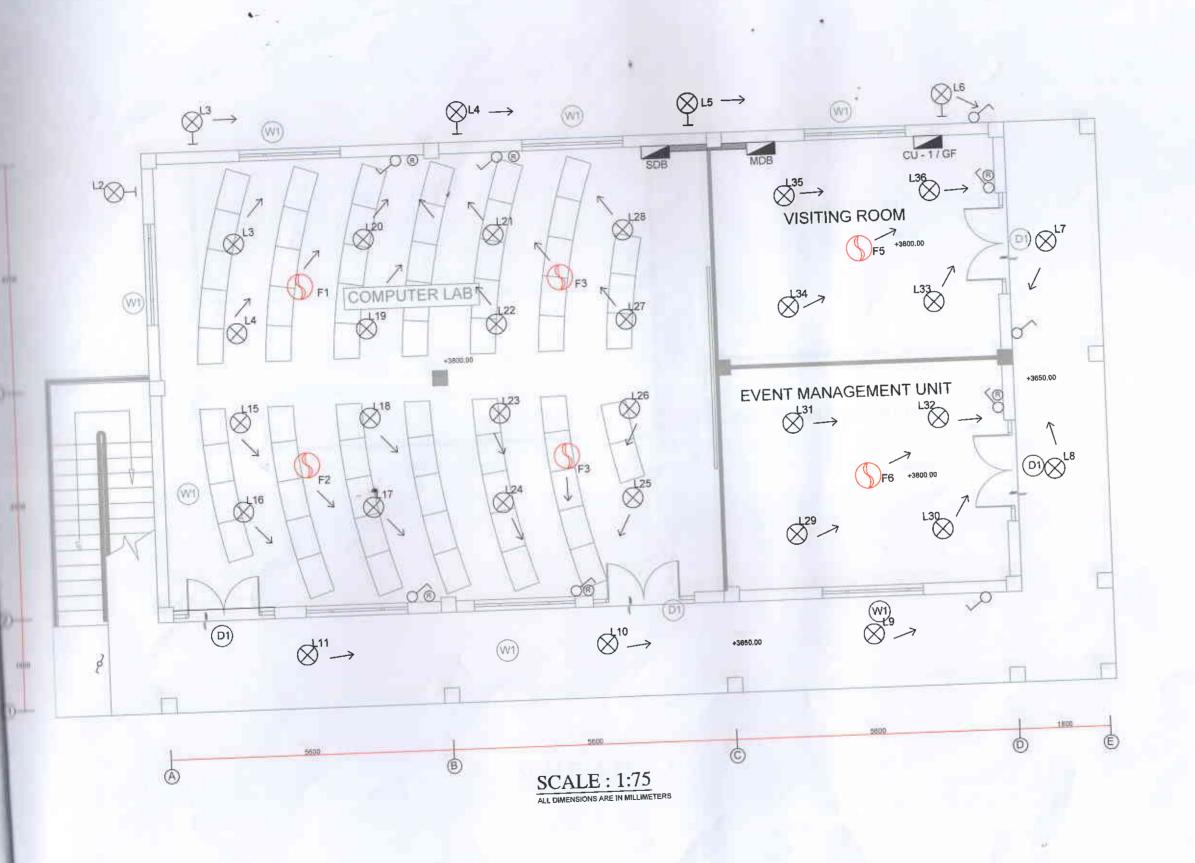

PROPOSED BUILDING FOR SMART
LEARNING ENVIRONMENT
(ACCELERATING HIGHER EDUCATION EXPANSION AND
DEVELOPMENT)

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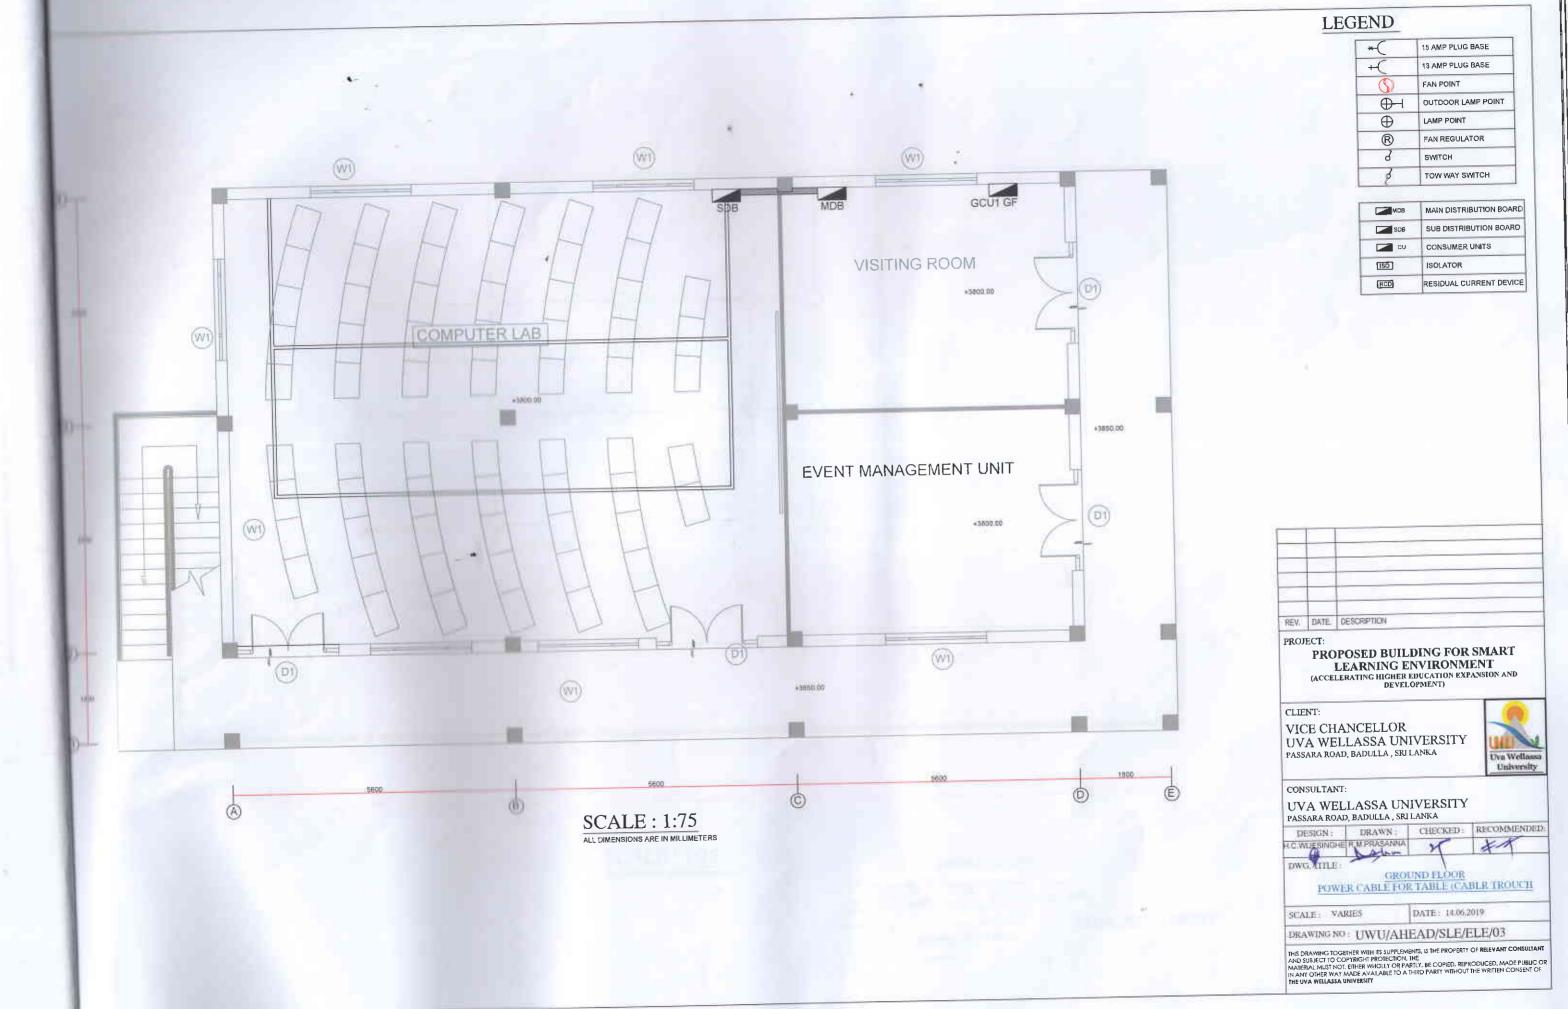
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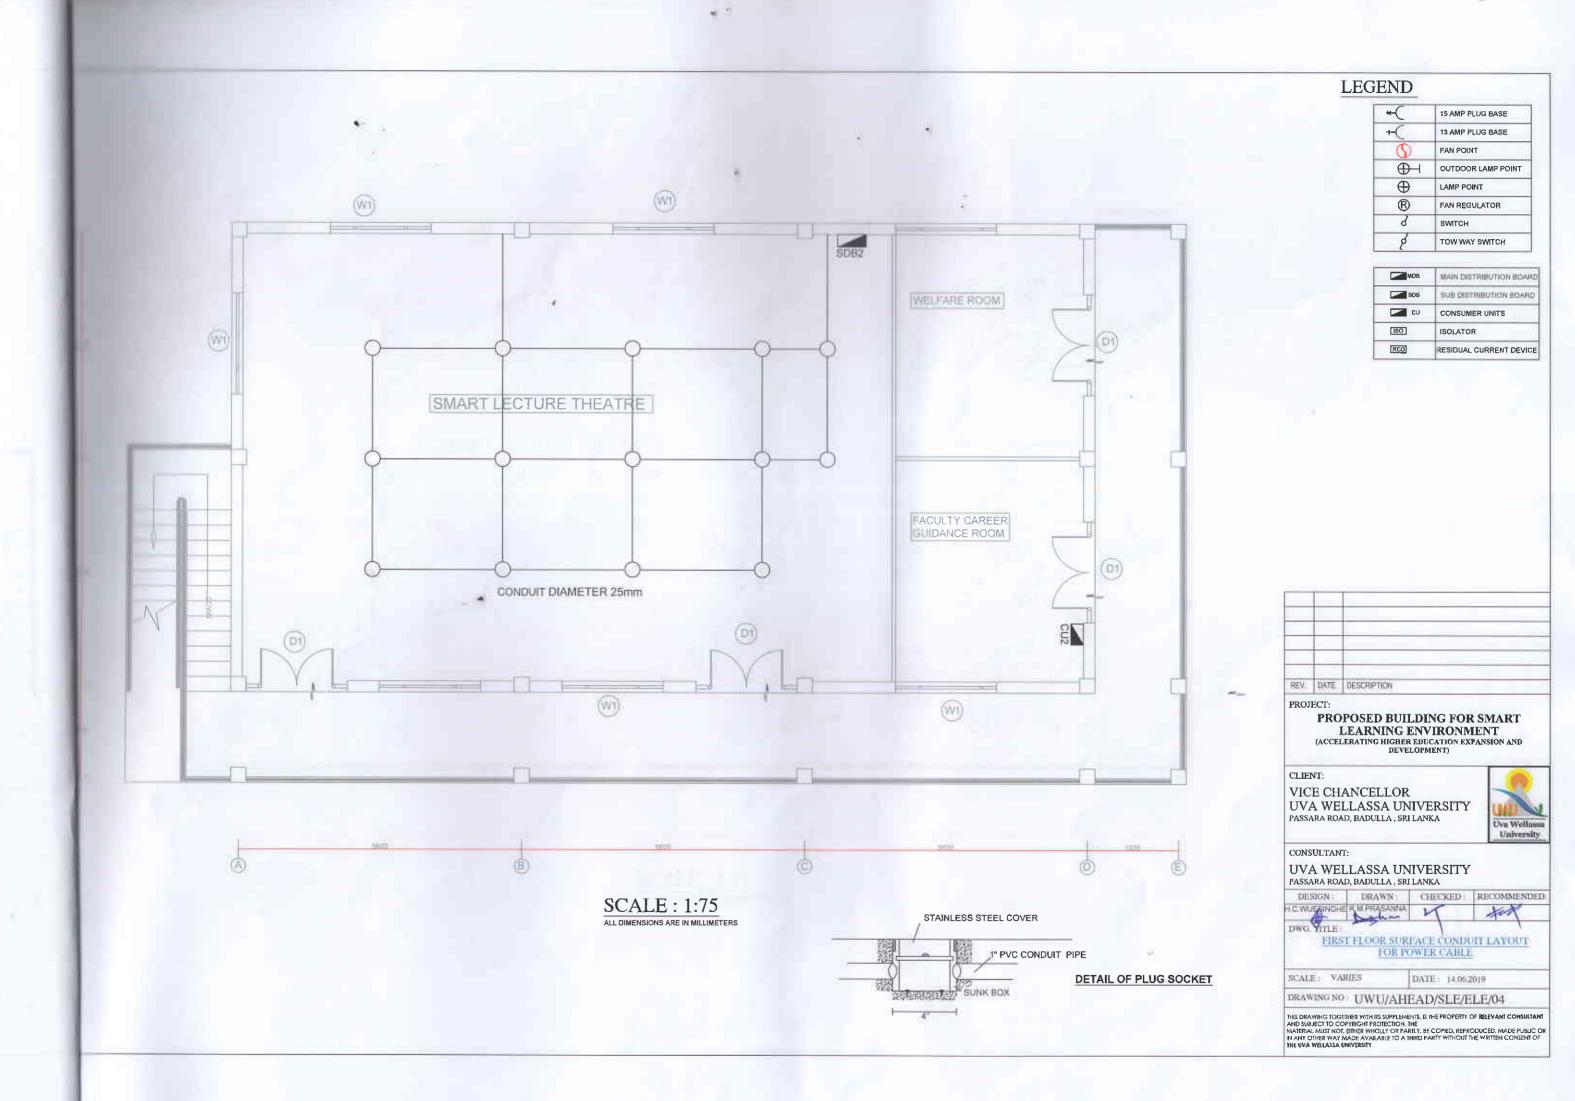
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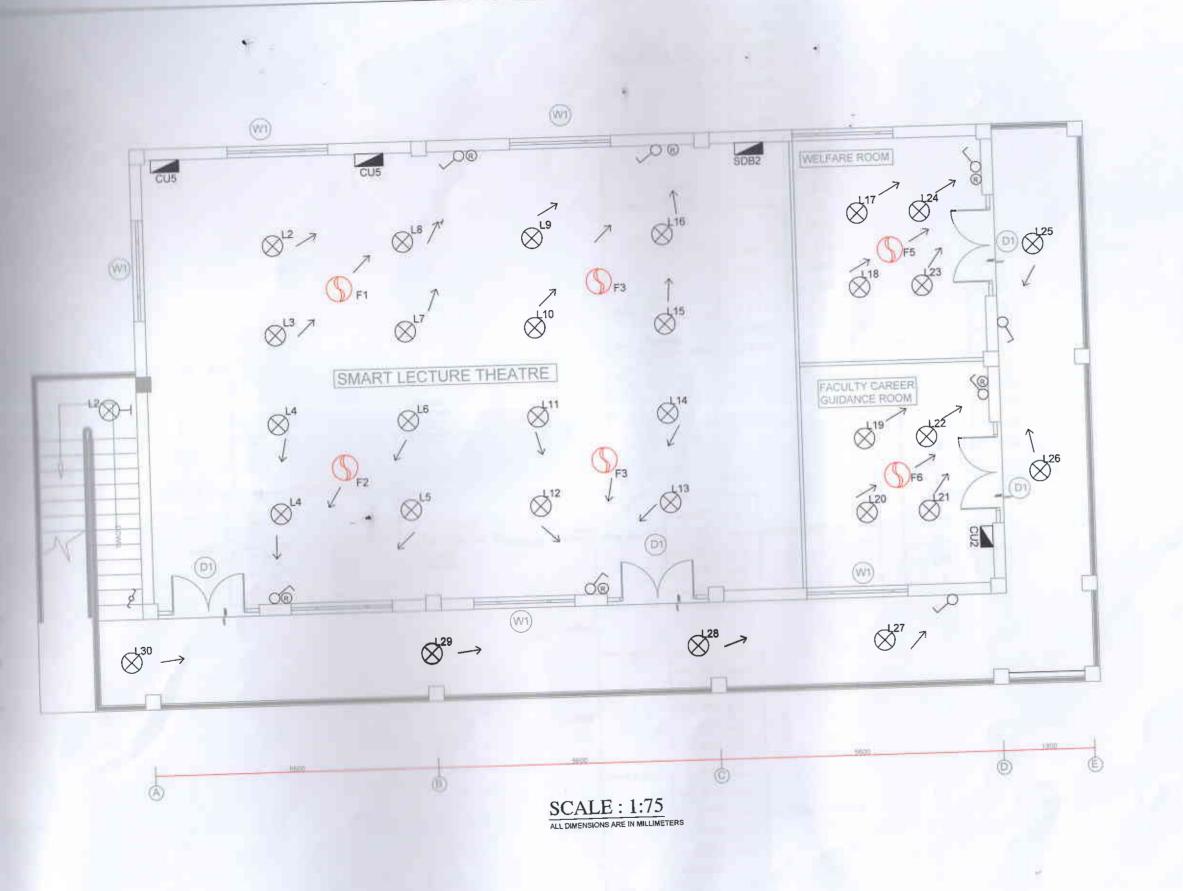
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MDB	MAIN DISTRIBUTION BOARD
SDB	SUB DISTRIBUTION BOARD
CU CU	CONSUMER UNITS
ISO.	ISOLATOR
RCD	RESIDUAL CURRENT DEVICE

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REV.	EATE	DESCRIPTION	

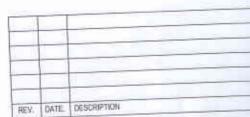PROPOSED BUILDING FOR SMART
LEARNING ENVIRONMENT
CACCELERATING HIGHER EDUCATION EXPANSION AND
DEVELOPMENT

CLIENT:

VICE CHANCELLOR UVA WELLASSA UNIVERSITY PASSARA ROAD, BADRILLA, SRI LANKA



CONSULTANT:

UVA WELLASSA UNIVERSITY PASSARA ROAD, BADULLA , SRI LANKA


DESIGN: DRAWN: CHECKED RECOMMENDED
HC WIJESPICHE R.M.FRASANNA
DWG. TITLE:

FIRST FLOOR LIGHT POINT AND FAN ARRANGEMENT

SCALE: VARIES

DATE: 14.06,2019

DRAWING NO: UWU/AHEAD/SLE/ELE/05

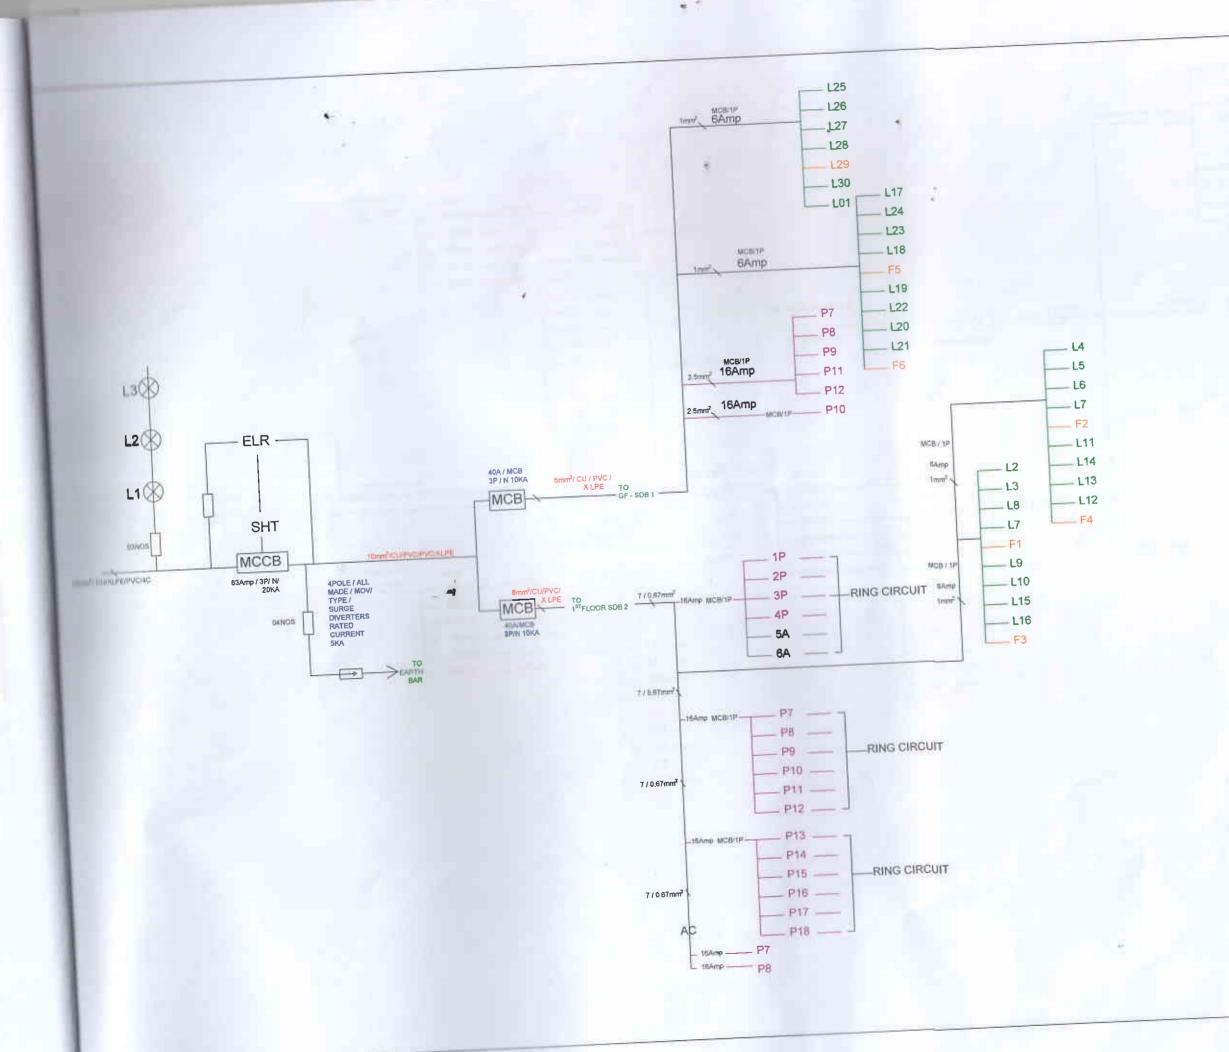

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MDB	MAIN DISTRIBUTION BOARD	
SDB	SUB DISTRIBUTION BOARD	
CU CU	CONSUMER UNITS	
ISO	ISOLATOR	
RCD	RESIDUAL CURRENT DEVICE	

1		
 	DESCRIPTION	

PROJECT: PROPOSED BUILDING FOR SMART
LEARNING ENVIRONMENT
(ACCELERATING HIGHER EDUCATION EXPANSION AND
DEVELOPMENT)

CLIENT:

VICE CHANCELLOR UVA WELLASSA UNIVERSITY PASSABA ROAD, BADAILLA, SRI LANKA



CONSULTANT:

UVA WELLASSA UNIVERSITY PASSARA ROAD, BADULLA, SRI LANKA

DESIGN	DRAWN DRAWN	CHECKED:	RECOMMENDE
H.C. WLIESINGHE	R.M.PRASANNA	M	17
DWG, THEE:	ELECTRIC!	INE DIAGR	AM 01

DATE: 14.06 2019

SCALE: VARIES

DRAWING NO: UWU/AHEAD/SLE/ELE/06

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